

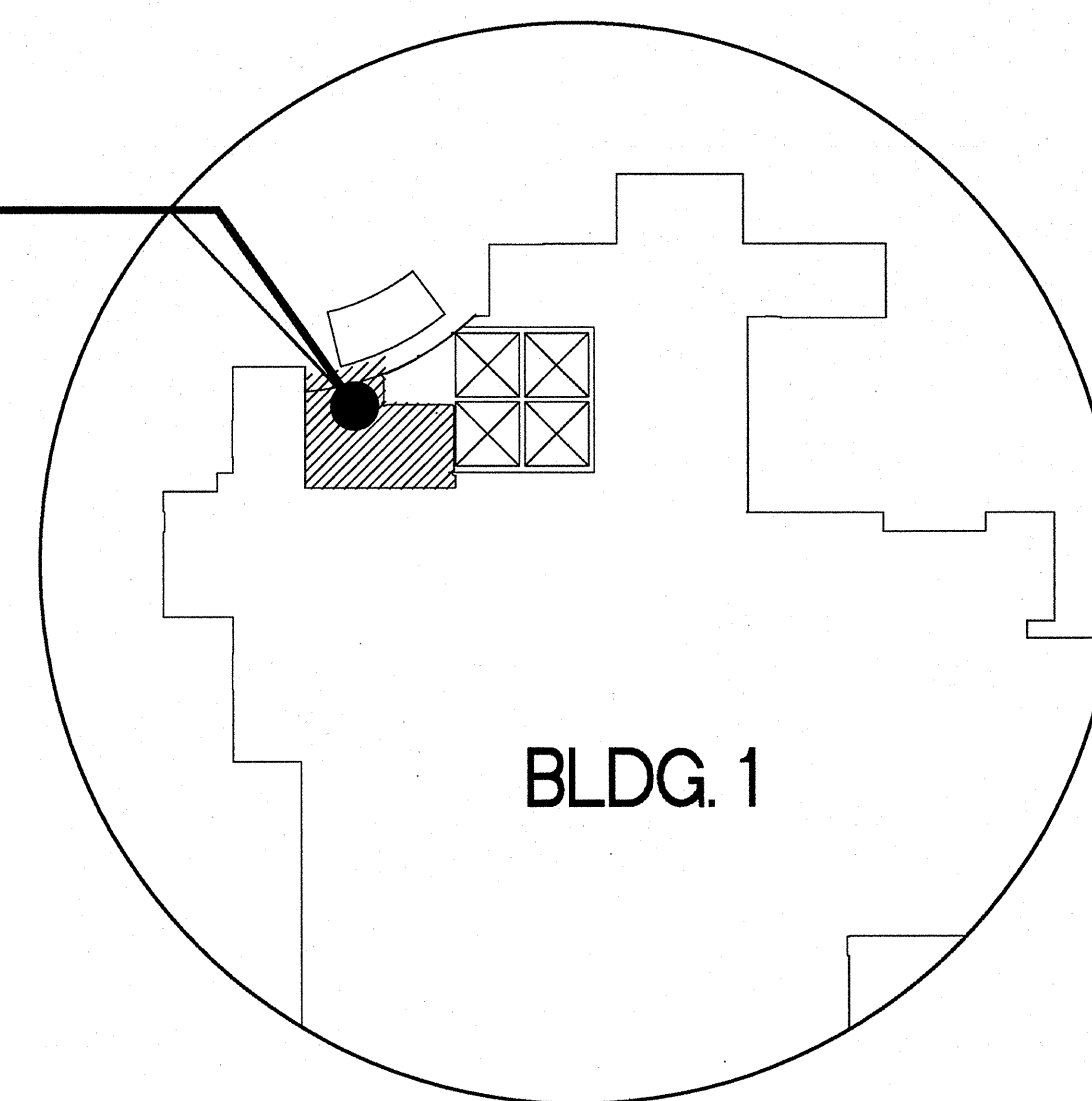
# OIF / OEF WELCOME CENTER DEPARTMENT OF VETERANS AFFAIRS VAMC

VA MEDICAL CENTER WASHINGTON, DC

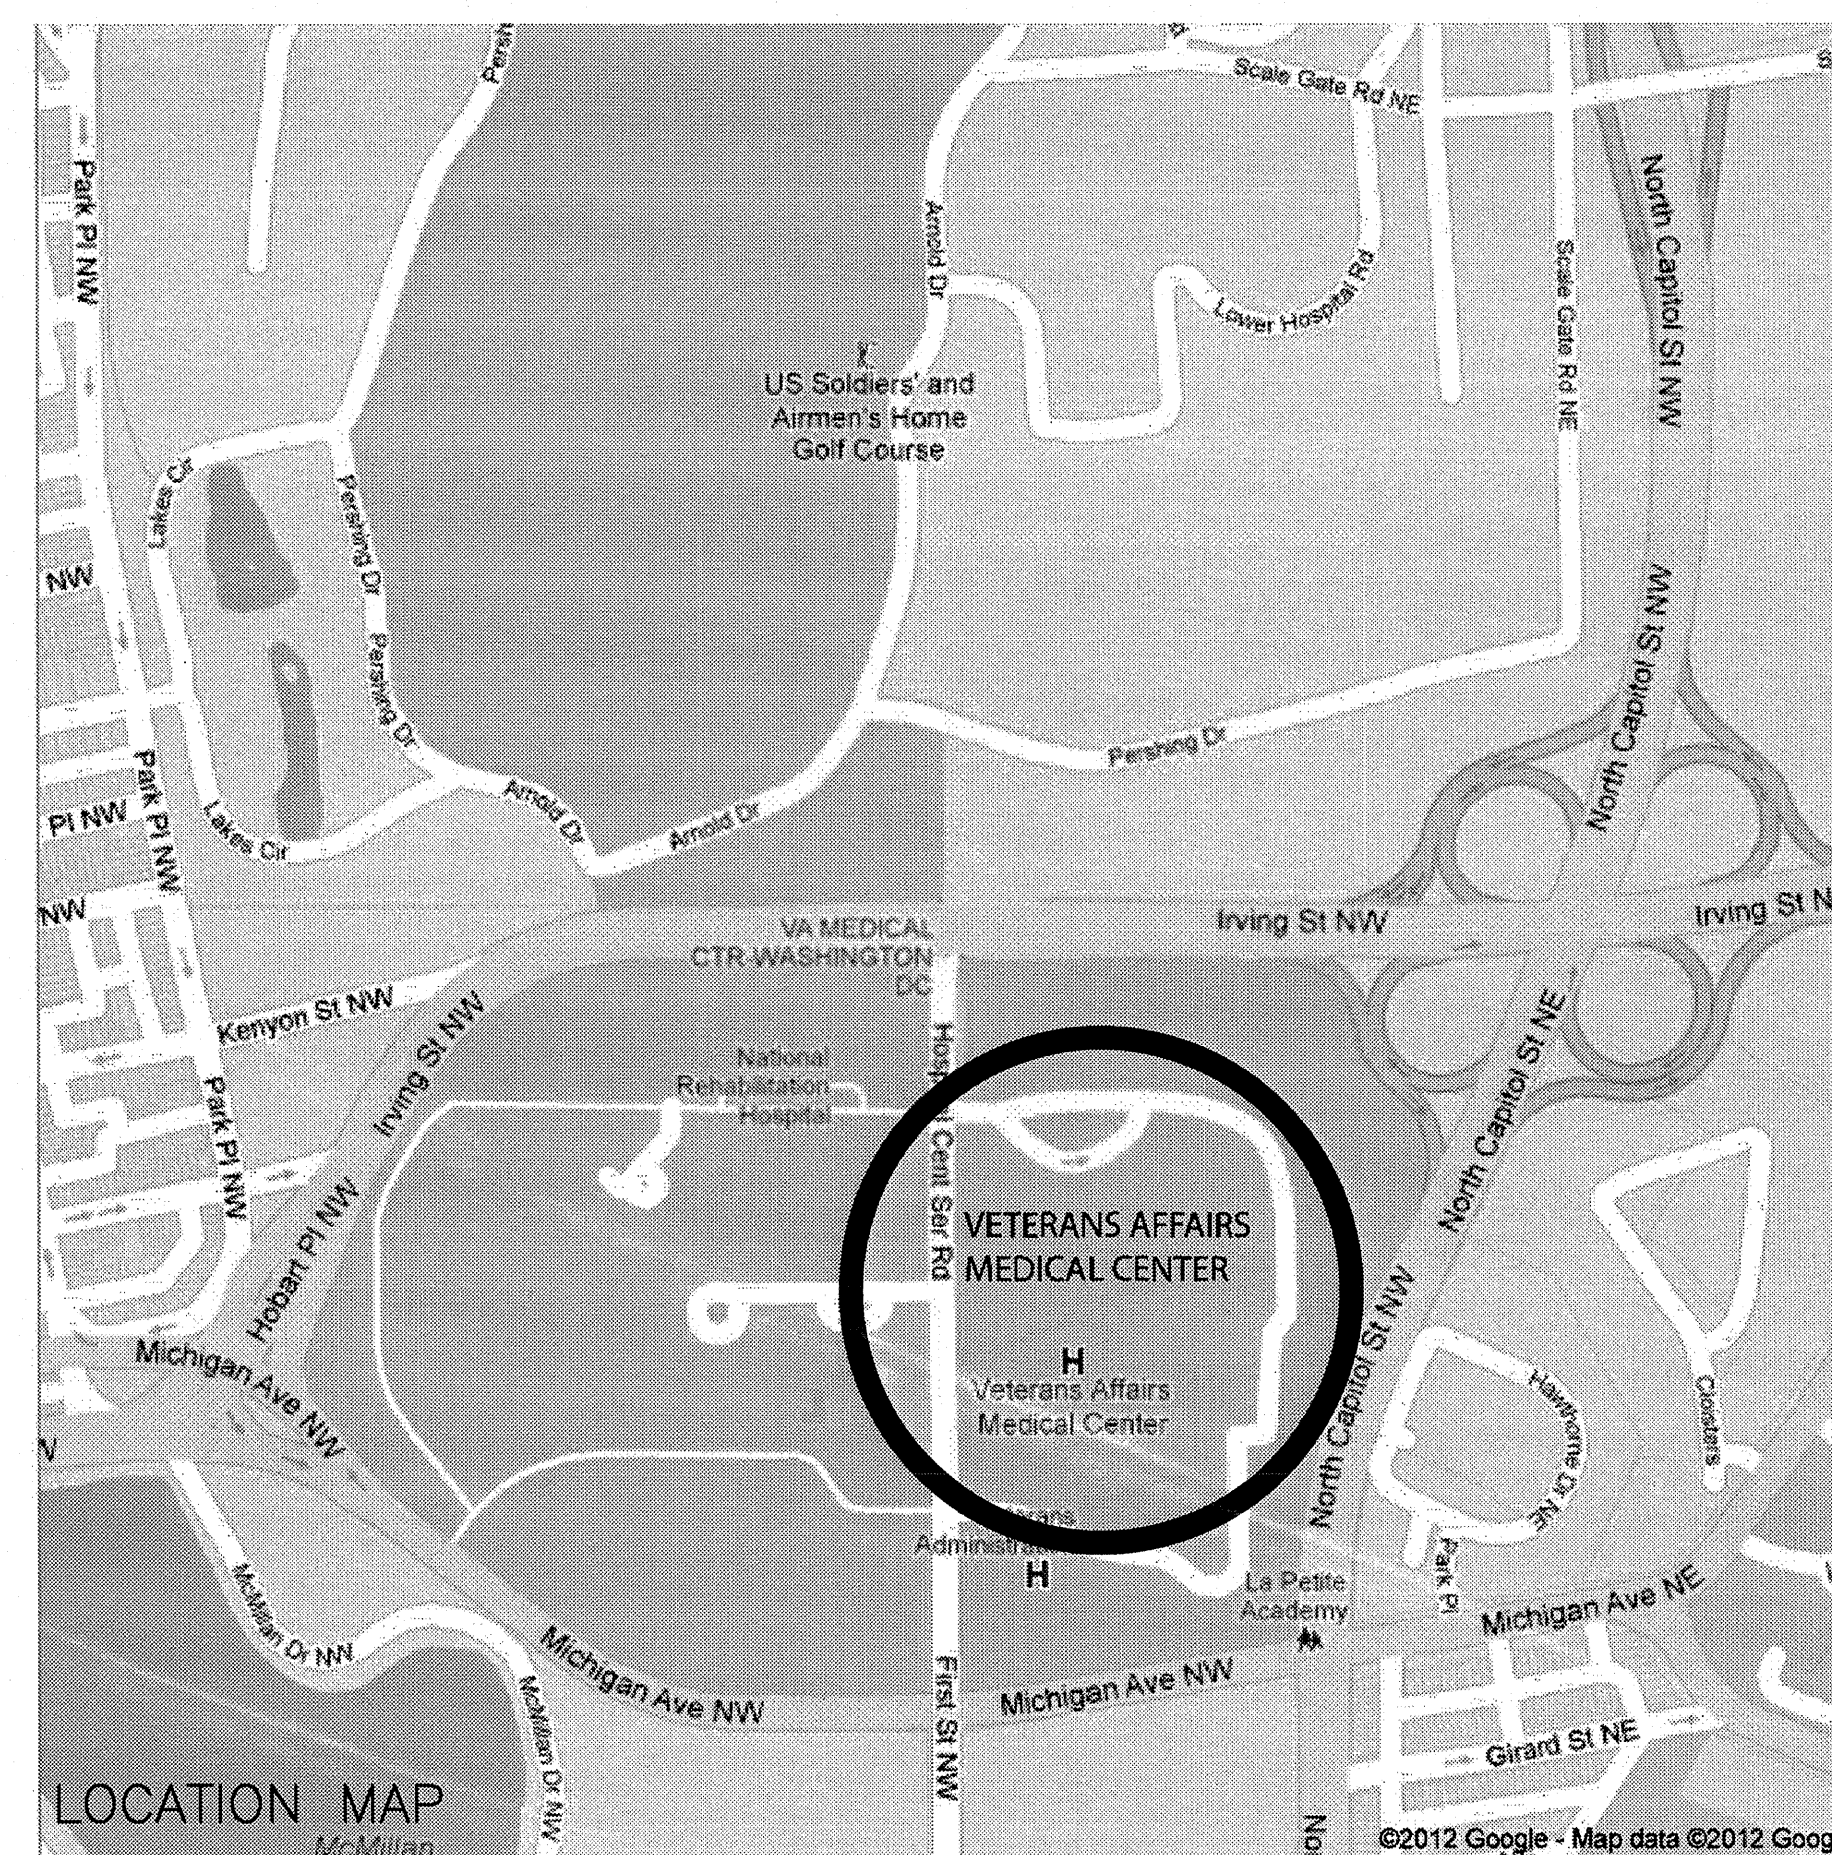
ISSUE 1 - ISSUE FOR CONSTRUCTION 04-30-2013



SITE



BLDG. 1



LOCATION MAP

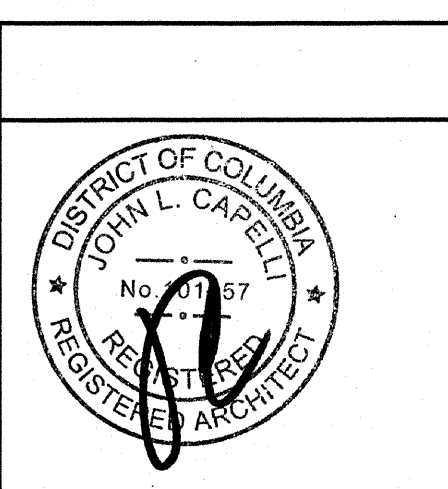
VICINITY MAP

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CONSULTANTS:	



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Drawing Title	COVER SHEET AND SITE MAP
Approved Project Director	

Project Title	OIF / OEF WELCOME CENTER DEPARTMENT OF VETERANS AFFAIRS VAMC
Location	Veterans Affairs Medical Center 50 Irving Street NW Washington DC
Date	4-30-2013
Checked	CH
Drawn	AN

Project Number	688-334 OIF/OEF
Building Number	
Drawing Number	G1001

Office of Construction and Facilities Management	
Department of Veterans Affairs	



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ARCHITECTURAL SYMBOLS

- CENTER LINE  
ELEVATION INDICATOR  
CENTER LINE INDICATOR  
CONTRACT LIMIT LINE  
DEMOLITION LINE  
EXISTING TO REMAIN LINE  
FEATURES ABOVE LINE INDICATOR  
FIRE RESISTIVE RATED LINE, 1 HOUR  
FIRE RESISTIVE RATED LINE, 2 HOUR  
FIRE RESISTIVE RATED LINE, 3 HOUR  
FIRE RESISTIVE RATED LINE, 4 HOUR  
FIRE-RATED, SMOKE BARRIER LINE, 1 HOUR  
FIRE-RATED, SMOKE BARRIER LINE, 2 HOUR  
FIRE-RATED, SMOKE BARRIER LINE, 3 HOUR  
FIRE-RATED, SMOKE BARRIER LINE, 4 HOUR  
HIDDEN FEATURES LINE  
NEW LINE  
PROPERTY LINE  
SMOKE BARRIER LINE  
BREAK, ROUND (USER DEFINES SIZE)  
BREAK, STRAIGHT (SEE SECTION INDICATORS, BUILDING, WITH BREAK STANDARDS)  
DETAIL INDICATOR  
DETAIL INDICATOR  
DETAIL INDICATOR FOR SMALL CONDITIONS  
DIMENSION LINE  
DOOR OPENING/BORROWED LIGHT IDENTIFIER  
DRAWING BLOCK TITLE, TYPICAL  
ELEVATION INDICATOR, EXTERIOR  
ELEVATION INDICATOR, INTERIOR, MULTIPLE VIEW  
ELEVATION INDICATOR, INTERIOR, SINGLE VIEW  
BUILDING SECTION INDICATOR

- DETAIL NUMBER  
SHEET WHERE REF.  
SHEET WHERE DRAWN  
FURNITURE, FIXTURE, & EQUIPMENT INDICATOR  
GRAPHIC SCALE, 1/8"=1'-0"  
ROOM NAME AND NUMBER  
COLUMN GRID  
KEYNOTE  
WALL OR PARTITION  
FIRE EXTINGUISHER CABINET  
CORNER GUARD  
NORTH ARROW  
V V ITEM - VA SUPPLIED & INSTALLED  
VC ITEM - VA SUPPLIED & CONTRACTOR INSTALLED  
CC ITEM - CONTRACTOR SUPPLIED & INSTALLED

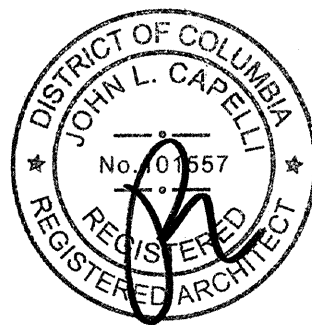
MATERIALS LEGEND

- CONCRETE  
EARTH  
BASE COURSE  
EXISTING CONSTRUCTION TO REMAIN  
EXISTING CONSTRUCTION TO BE REMOVED  
NEW CONSTRUCTION  
RIGID INSULATION  
BATT INSULATION

- GENERAL DEMOLITION AND ALTERATION NOTES
- CONTRACTOR SHALL NOT CONSIDER DEMOLITION AND ALTERATION NOTES TO BE ALL INCLUSIVE. IT IS THE CONTRACTOR'S RESPONSIBILITY TO INSPECT AND ASSESS EACH AREA AND TO FULFILL THE INTENT OF THE WORK INDICATED BY THE CONTRACT DOCUMENTS. CONTRACTOR SHALL VERIFY ALL CONDITIONS AND DIMENSIONS WITHIN THE CONTRACT LIMITS. DEVIATIONS FROM THE CONTRACT DOCUMENTS NECESSITATED BY FIELD CONDITIONS SHALL BE BROUGHT TO THE ATTENTION OF THE ARCHITECT.
  - CONTRACTOR SHALL CONSULT WITH THE OWNER IN ADVANCE OF DOING WORK, TO DETERMINE DISPOSITION OF ALL FIXTURES, CABINETS, SERVICES, EQUIPMENT AND ITEMS REMOVED DURING DEMOLITION.
  - PROVIDE TEMPORARY DUST BARRIERS, BARRICADES, ETC. TO PROTECT PERSONNEL AND ADJACENT SPACES AS REQUIRED OR SHOWN ON DRAWINGS. WHERE USED IN FIRE RATED WALLS OR PARTITIONS, THE TEMPORARY CONSTRUCTION SHALL MATCH FIRE RATING.
  - WHERE ANY EXISTING CONSTRUCTION (I.E., PARTITIONS, FLOORS AND BASES, DOOR AND WINDOW FRAMES, CEILINGS, CASEWORK, EQUIPMENT, HVAC, ELECTRICAL AND PLUMBING FIXTURES) IS REMOVED OR ALTERED, REPAIR ALL ADJACENT SURFACES DISTURBED BY DEMOLITION OR ALTERATION WORK AND PREPARE TO RECEIVE NEW CONSTRUCTION AND/OR PROVIDE NEW SCHEDULED FINISHES.
  - WHERE NEW CONSTRUCTION OCCURS IN EXISTING WALLS OR PARTITIONS WHICH ARE FIRE RATED, MATERIALS USED SHALL BE SUFFICIENT TO MAINTAIN FIRE RATING.
  - WHERE PARTITIONS ARE REMOVED AT COLUMNS AND WALLS, EXISTING FINISH AROUND COLUMNS SHALL BE REMOVED, COLUMNS SHALL REMAIN AND NEW CONSTRUCTION AND FINISHES SHALL BE APPLIED TO MATCH NEW ADJACENT AND/OR SIMILAR CONDITIONS.
  - UNLESS NOTED OTHERWISE, REMOVE EXISTING PROJECTIONS, HANGERS, BOLTS, NAILS, BRACKETS, CURTAIN RODS, VALANCES, ETC. FROM EXISTING WALLS AND COLUMNS. PATCH ALL HOLES TO MATCH ADJACENT SURFACES AND/OR PROVIDE NEW SCHEDULED FINISHES.
  - AT NEW DOORS, CORRIDOR OPENINGS OR CONNECTIONS AND WHERE PARTITIONS ARE REMOVED, REMOVE EXISTING FLOORING AND BASES TO EXTENT REQUIRED FOR NEW UNDERLAYMENT TO PROVIDE A SMOOTH TRANSITION. THE SUBSURFACE SHALL BE PATCHED AND TREATED TO PRODUCE A SURFACE WHICH WILL ELIMINATE "TELEGRAPHING" OF EXISTING JOINTS THROUGH THE NEW FLOORING.
  - WHERE CERAMIC TILE FLOORING EXISTS IN SPACES TO RECEIVE NEW FINISH, REMOVE EXISTING CERAMIC TILE AND SETTING BED AND FILL WITH UNDERLAYMENT AS REQUIRED TO RECEIVE NEW FINISHES. WALL TILE AT EXISTING SHOWER AND WAINSCOT CONDITIONS SHALL BE REMOVED AND EXISTING SURFACE PREPARED AND/OR NEW SURFACE INSTALLED TO RECEIVE NEW SCHEDULED FINISHES. AREAS WHERE EXISTING CERAMIC TILE COULD BE COVERED BY NEW REQUIRED FURRING, EXISTING TILE NEED NOT BE REMOVED.
  - REMOVE EXISTING SUSPENDED ACOUSTIC TILE AND/OR PLASTER CEILING TO EXTENT REQUIRED TO ACCOMMODATE NEW HVAC, PLUMBING AND ELECTRICAL WORK IN THE SPACES WHERE SUCH WORK IS SHOWN ON MECHANICAL AND ELECTRICAL DRAWINGS. AFTER HVAC, PLUMBING AND ELECTRICAL WORK IS COMPLETE, AND IF NEW CEILING IS NOT REQUIRED BY FINISH SCHEDULE, PATCH AND REPAIR EXISTING CEILING TO MATCH ADJACENT CEILING. COMPLETE REMOVAL OF EXISTING CEILINGS FOR OTHER REASONS IS INDICATED ON DEMOLITION DRAWINGS.
  - UNLESS OTHERWISE NOTED ON DOCUMENTS, ALL PAINTING SHALL BE FROM A BREAK IN PLANE TO A BREAK IN PLANE REGARDLESS OF AREA ACTUALLY REPAIRED OR DISTURBED. WHERE EXISTING OR NEW CERAMIC TILE OCCURS WITHIN A SCHEDULED PAINT FINISH AREA, CERAMIC TILE SHALL REMAIN UNPAINTED.
  - WHERE FANS, AIR-CONDITIONING UNITS, LOUVERS OR OTHER WINDOW MOUNTED DEVICES ARE REMOVED, THE WINDOW SASH SHALL BE REPLACED AND/OR REGAZED AND MADE OPERABLE. WHERE SUCH DEVICES ARE REMOVED FROM EXTERIOR MASONRY WALLS, CLOSE OPENING TO MATCH EXISTING ADJACENT AND/OR SIMILAR CONSTRUCTION.
  - REMOVAL OF UTILITIES SHOWN ON DEMOLITION DRAWINGS SHALL BE ACCOMPLISHED BY INDIVIDUAL TRADES (E.G., FIXTURE REMOVAL CAPPING, ETC., TO BE BY PLUMBING CONTRACTOR) AND ARE INDICATED HERE FOR PURPOSES OF SCOPE. SEE HVAC, PLUMBING AND ELECTRICAL DRAWINGS FOR ADDITIONAL DEMOLITION WITHIN RESPECTIVE TRADES. MECHANICAL, PLUMBING AND/OR ELECTRICAL FIXTURES REQUIRED TO BE REMOVED OR RELOCATED DUE TO NEW CONSTRUCTION AND/OR DEMOLITION OF EXISTING CONSTRUCTION SHALL BE REMOVED AND/OR RELOCATED BY THE RESPECTIVE TRADES.
  - WHERE DRAWINGS CALL FOR REMOVAL OF EXISTING HVAC, PLUMBING AND ELECTRICAL FIXTURES OR EQUIPMENT, REMOVE ALL ABANDONED SERVICES AND REROUTE OR CAP BEHIND LINE OF NEW CONSTRUCTION AND FINISHES. ALL EXISTING AND NEW UTILITIES TO BE CONCEALED BY NEW CONSTRUCTION.
  - EXISTING DUCTS, PIPES, ELECTRICAL CONDUIT, ETC. TO REMAIN AND EXPOSED IN FINISH SPACES SHALL BE CONCEALED IN NEW AND/OR EXISTING CONSTRUCTION. NEW DUCTS, PIPES, CONDUITS, ETC. SHALL BE CHASED INTO WALLS AND FINISHED TO MATCH ADJACENT SURFACES.
  - NEW ELECTRICAL AND FIRE ALARM PANELS AND THEIR ATTENDANT CONDUITS SHALL BE RECESSED IN NEW AND/OR EXISTING WALLS. PROVIDE OPENINGS, PATCH TO MATCH ADJACENT SURFACES OR PROVIDE NEW SCHEDULE FINISHES.
  - DUCT, PIPE, CONDUIT AND OTHER HOLES IN THE FLOOR, EITHER EXISTING OR RESULTING FROM DEMOLITION OR NEW WORK REQUIREMENTS, SHALL BE FILLED IN SOLID WITH CONCRETE.
  - PATCH EXISTING DAMAGE TO WALLS, COLUMNS, FLOORS AND CEILINGS THAT ARE TO REMAIN. REPAIRS SHALL MATCH EXISTING ADJACENT AND/OR SIMILAR SURFACES AND MATERIALS.
  - REMOVE EXISTING CORNER GUARDS AT LOCATIONS WHERE NEW PARTITIONS ABUT SUCH WALL OR COLUMN CORNERS. REPAIR WALL OR COLUMN AS REQUIRED AFTER REMOVAL.
  - ALL NEW SUSPENDED CEILINGS MUST BE SUSPENDED FROM EXISTING STRUCTURE. EXISTING SUSPENDED CEILINGS, (ACOUSTIC TILE AND/OR PLASTER) SHALL BE REMOVED COMPLETELY TO ALLOW INSTALLATION OF NEW SUSPENSION SYSTEM TO EXISTING STRUCTURE. NOTE THAT SOME AREAS HAVE EXISTING SUSPENDED PLASTER CEILINGS CONCEALED ABOVE ACOUSTICAL TILE CEILINGS AND THESE CONCEALED CEILINGS SHALL BE REMOVED.

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Drawing Title	GENERAL NOTES AND SYMBOL LEGEND
Approved Project Director	

Project Title	OFF / OEF WELCOME CENTER DEPARTMENT OF VETERANS AFFAIRS VAMC
Location	Veterans Affairs Medical Center 50 Irving Street NW Washington DC
Date	4-30-2013
Checked	CH
Drawn	AN

Project Number	688-334 OFF/OEF
Building Number	
Drawing Number	GI002
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Office of Construction and Facilities Management	Department of Veterans Affairs
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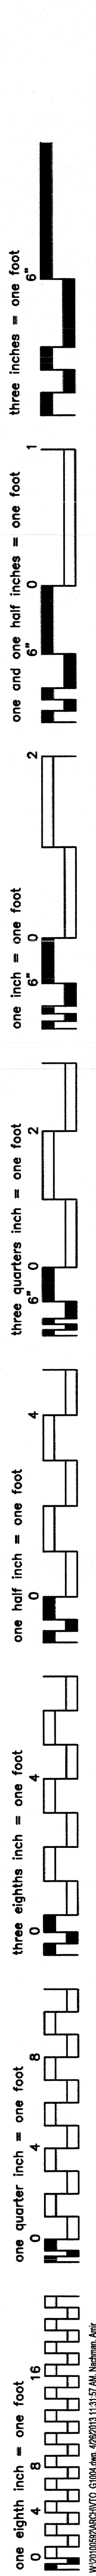


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ARCHITECTURAL ABBREVIATIONS														
A LABEL	CLASS A DOOR	BUR	BUILT-UP ROOFING	DEMO	DEMOLITION	FLG	FLOORING	HW	HOT WATER	MISC	MISCELLANEOUS	PL GL	PLATE GLASS	
A/C	AIR CONDITION			DEPT	DEPARTMENT	FLR	FLOOR	HYD	HYDRANT	MIT	MITER	PLAM	PLASTER LAMINATE	
A/C UNIT	AIR CONDITIONING UNIT	C	CELSIUS CHANNEL	DET	DETAIL	FLR FIN	FLOOR FINISH			MKR	MARKER	PLAS	PLASTER OR PLASTIC	
A/E	ARCHITECT/ENGINEER	C	CHANNEL CELSIUS	DF	DRINKING FOUNTAIN	FLR SK	FLOOR SINK			ML	METAL LATH	PLBG	PLUMBING	
AAMA	AMERICAN ARCHITECTURAL MANUFACTURERS ASSOCIATION	C CONC	CAST CONCRETE	DIA	DIAMETER	FLUOR	FLUORESCENT	I	INTERSTATE (HIGHWAY) OR	MLDG	MOLDING (MOULDING)	PLYWD	PLYWOOD	
AB	ANCHOR BOLT	C LABEL	CLASS C DOOR	DIAG	DIAGONAL DIAGRAM	FLUOR FIX	FLUORESCENT FIXTURE	IAQ	MOMENT OF INERTIA	MLWK	MILLWORK	PMTL	PAINTED METAL	
ABC	AGGREGATE BASE COURSE	C TO C	CENTER TO CENTER	DIAG FM	DIAGONAL MUTUAL			IBC	INDOOR AIR QUALITY	mm	MILLIMETER	PNEU	PNEUMATIC	
AC	ASBESTOS CEMENT OR ASPHALTIC CONCRETE	CAB	CABINET	DIFF	DIFFERENCE OR DIFFUSER	FM-G	FACTORY MUTUAL GLOBAL	ID	IDENTIFICATION, INSIDE	MO	MASONRY OPENING OR MOTOR OPERATED	PNL	PANEL	
ACI	AMERICAN CONCRETE INSTITUTE	CAC	CEILING ATTENUATION CLASS	DIM	DIMENSION	FO	FINISHED OPENING			MOD	MODEL, MODIFY OR MODULE	PO	POST OFFICE PURCHASE ORDER	
ACS DR	ACCESS DOOR	CB	CATCH BASIN OR CORNER BEAD	DIR	DIRECTION	FOC	FACE OF CONCRETE OR FACE OF CURB	ID NO	IDENTIFICATION NUMBER	MOD BIT	MODIFIED BITUMEN	POLY	POLYETHYLENE (PLASTIC)	
ACS FLR	ACCESS FLOOR	CBB	CEMENTITIOUS (BACKER) BOARD	DISP	DISPENSER	FOF	FACE OF FINISH	ILLUM	ILLUMINATION	MON	MONITOR	PR	PAIR	
ACS PNL	ACCESS PANEL	CC	CUBIC CENTIMETER	DIST	DISTANCE	FOM	FACE OF MASONRY	INCL	INCLUDED	MOPR	MOP RACK	PRCST	PRECAST	
ACST	ACOUSTIC	CCTV	CLOSED CIRCUIT TELEVISION	DIV	DIVIDE OR DIVISION	FOS	FACE OF SLAB OR FACE OF STUD	IND	INDEPENDENT OR INDUSTRIAL	MR	MOISTURE RESISTANT	PREFAB	PREFABRICATE	
ACT	ACOUSTICAL CEILING TILE	CCW	COUNTERCLOCKWISE	DOC	DOCUMENT			INFO	INFORMATION	MS	MACHINE SCREW OR MOP SINK	PREFIN	PREFINISH	
AD	AREA DRAIN	CD	CONSTRUCTION DOCUMENTS OR CONTRACT DOCUMENTS	DOUG FIR	DOUGLAS FIR	FOUNT	FOUNTAIN	INSUL	INSULATION	MTD	MOUNTED	PRELIM	PRELIMINARY	
ADA	AMERICANS WITH DISABILITIES ACT	CEM	CEMENT	DOZ	DOZEN	FP	FACE OF WALL	INT	INTERIOR	MTG	MOUNTING	PREP	PREPARATION	
ADC	AUTOMATIC DOOR CLOSER	CEM PLAS	CEMENT PLASTER	DR	DOOR, DRAIN, DRESSING ROOM, OR DRIVE	FR	FIRE PROTECTION OR FIREPROOF	INTERCOM	INTERCOMMUNICATION	MTL	METAL	PRESS	PRESSURE	
ADDL	ADDITIONAL	CER	CERAMIC	DR CL	DOOR CLOSER	FPM	FEET PER MINUTE	IRMA	INVERTED ROOF MEMBRANE ASSEMBLY	MULL	MULLION	PRKY	PARKING	
ADDN	ADDITION	CF	CONTRACTOR FURNISHED	DR FR	DOOR FRAME	FPS	FEET PER SECOND	IWH	INSTANTANEOUS WATER HEATER	MWP	MEMBRANE WATERPROOFING	PRMLD	PREMOLDED	
ADH	ADHESIVE	CF/CI	CONTRACTOR	DR OPNG	DOOR OPENING	FR	FIRE RATING, FIRE RESISTANT, OR FRAME	JAN	JANITOR	N	NORTH	PROJ	PROJECT	
ADJ	ADJACENT, ADJOINING, OR ADJUSTABLE	CF/OI	FURNISHED/CONTRACTOR	DR OPNG	DOOR OPENING	FR SNK	FREQUENCY	J-BOX	JUNCTION BOX	NA	NOT APPLICABLE	PROP	PROPERTY	
ADMIN	ADMINISTRATION	CG	CONTRACTOR FURNISHED/OWNER INSTALLED	DSGN	DESIGN	FREQ	FREQUENCY	KD	KILN DRIED OR KNOCKED DOWN	NAAMM	NATIONAL ASSOCIATION OF ARCHITECTURAL METAL MANUFACTURERS	PSF	POUNDS PER SQUARE FOOT	
ADB	AUTOMATIC DOOR BOTTOM	CFLG	COUNTERFLASHING	DW	DISHWASHER	FRMG	FRAMING	KIT	KITCHEN	NAT	NATURAL	PTD	PAPER TOWEL DISPENSER	
AFC	ABOVE FINISHED COUNTER	CFM	CUBIC FEET PER MINUTE	DWG	DRAWING	FRP	FIBER REINFORCED POLYESTER OR FIBERGLASS REINFORCED PLASTIC	KO	KNOCKOUT	NATL	NATIONAL	PTN	PARTITION	
AFF	ABOVE FINISHED FLOOR	CFMF	COLD-FORMED METAL FRAMING	DWTR	DUMBWAITER	FRZ	FREEZER	KPL	KICKPLATE	NC	NOISE CRITERIA	PVC	POLYVINYL CHLORIDE (PLASTIC)	
AFG	ABOVE FINISHED GRADE	CFS	CUBIC FEET PER SECOND	E	E LABEL	FS	FEDERAL SPECIFICATION	L	LABORATORY	NEC	NEGATIVE	PWG	PAVING	
AFS	ABOVE FINISHED SLAB	CG	CENTER OF GRAVITY OR CORNER GUARD	EA	EACH	FSNTR	FASTENER	LAD	LADDER	NEG	NEGATIVE	QA	QUALITY ASSURANCE	
AGA	AMERICAN GAS ASSOCIATION	CGSFU	CERAMIC GLAZED STRUCTURAL FACING UNITS	EFF	EFFICIENCY	FT	FEET OR FOOT	LAM	LAMINATE	NEMA	NATIONAL ELECTRICAL MANUFACTURERS ASSOCIATION	QC	QUALITY CONTROL	
AGC	ASSOCIATED GENERAL CONTRACTORS	CH BD	CHALKBOARD	EFS	EXTERIOR FINISH SYSTEM	FTG	FOOTING	LAM GL	LAMINATED GLASS	NEUT	NEUTRAL	QRY	QUARRY	
AGGR	AGGREGATE	CHEM	CHEMICAL	EIFS	EXTERIOR INSULATION AND FINISH SYSTEM	FURG	FURRING	LAU	LAUNDRY	NFC	NATIONAL FIRE CODE	QT	QUARRY TILE	
AHJ	AUTHORITY HAVING JURISDICTION	CHFR	CHEMICAL	EJ	EXPANSION JOINT	FURN	FURNISH OR FURNITURE	LAV	LAVATORY	NFPA	NATIONAL FIRE PROTECTION ASSOCIATION	QTB	QUARRY TILE BASE	
AHR	ANCHOR	CHK	CHECK	EL	ELEVATION	FUT	FUTURE	LBR	LUMBER			QTF	QUARRY TILE FLOOR	
AHU	AIR HANDLING UNIT	CHK	CHECK	ELAST	ELASTOMERIC	FWC	FABRIC WALLCOVERING	LBS	POUND			QTR	QUARTER	
AIA	AMERICAN INSTITUTE OF ARCHITECTS	CIP	CAST-IN-PLACE	ELEC	ELECTRIC			LD BRG	LOAD-BEARING	NIC	NOT IN CONTRACT	QTY	QUANTITY	
AISC	AMERICAN INSTITUTE OF STEEL CONSTRUCTION	CIR	CIRCULAR	ELEC DR OP	ELECTRIC DOOR OPENER			LDR	LEADER	NO	NUMBER	QTR	QUARTER	
ALT	ALTERNATE	CIRC	CIRCULAR	ELEV	ELEVATOR			LED	LIGHT EMITTING DIODE	NOM	NOMINAL	QUAD	QUADRANT	
ALT NO	ALTERNATE NUMBER	CJ	CONSTRUCTION JOINT OR CONTROL JOINT	EMER	EMERGENCY	EMER SHR	EMERGENCY SHOWER	LF	LINEAR FEET (FOOT)	NR	NOISE REDUCTION	QUAL	QUALITY	
ALUM	ALUMINUM	CL	CENTER LINE	ENCL	ENCLOSURE			LH	LEFT HAND	NRCA	NATIONAL ROOFING CONTRACTORS ASSOCIATION	R	RADIUS OR RISER	
ALUM	AMPERE	CLDG	CLADDING	ENGR	ENGINEER	GB	GRAB BAR	LHR	LEFT HAND REVERSE			RA	RETURN AIR	
AMP	AMOUNT	CLG	CEILING	ENVR	ENVIRONMENT	GC	GENERAL CONTRACTOR	LHR	LEFT HAND REVERSE LATENT	NRP	NONREMOVABLE	RAD	RADIATOR	
ANOD	ANODIZE	CLG HT	CEILING HEIGHT	EPA	ENVIRONMENTAL PROTECTION AGENCY	GDR	GUARD RAIL			NS	NONREMOVABLE	RB	RESILIENT BASE OR RUBBER BASE	
ANSI	AMERICAN NATIONAL STANDARDS INSTITUTE	CLR	CLEAR	EPDM	ETHYLENE PROPYLENE DIENE MONOMER	GEN	GENERAL OR GENERATOR	LIB	LIBRARY	NUM	NUMERAL	RB HK	ROBE HOOK	
ANT	ANTENNA	cm <sup>2</sup>	SQUARE CENTIMETER	EPS	EXPANDED POLYSTYRENE BOARD (INSULATION)	GFRG	GLASS-FIBER-REINFORCED CONCRETE	LIN	LINEAR			RBM	REINFORCED BRICK MASONRY	
APA	AMERICAN PLYWOOD ASSOCIATION	cm <sup>3</sup>	CUBIC CENTIMETER	EQL	EQUAL	GFRC	GLASS-FIBER-REINFORCED CONCRETE	LINO	LINEOLEUM	O/O	OUT TO OUT	RBR	RUBBER	
APPD	APPROVED	CM	CONSTRUCTION MANAGEMENT	EOL SP	EQUALLY SPACED	GFRP	GLASS-FIBER-REINFORCED CONCRETE	LIQ	LIQUID	OA	OUTSIDE AIR OR OVERALL	RC	REMOTE CONTROL	
APPROX	APPROXIMATE	CMU	CONCRETE MASONRY UNIT	EQ	EQUIVALENT			LKR	LOCKER			RCP	REFLECTED CEILING PLAN	
APT	APARTMENT	CNR	CORNER	EQU	EQUIVALENT			LKR RM	LOCKER ROOM	OC	ON CENTER	RCVR	RECEIVER	
AR	AS REQUIRED	CO	COUNTER	EQV	EQUIVALENT	GI	GALVANIZED IRON	LKWASH	LOCKWASHER	OCC	OCCUPY	RD	ROAD OR ROOF DRAIN	
ARCH	ARCHITECT	CONSTR	CARBON MONOXIDE, CERTIFICATE OF OCCUPANCY, CLEANOUT, OR COMPANY	ERD	EXISTING ROOF DRAIN	GL	GLASS	LL	LEAD LINED	OCT	OCTAGON	REC	RECESS	
ASB	ASBESTOS	COL	CARBON DIOXIDE	ESC	ESCAPE OR ESCUTCHEON	GL BLK	GLASS BLOCK	LLH	LONG LEG HORIZONTAL	OD	OUTSIDE DIAMETER OUTSIDE DIMENSION	RECQ	RECEIVED	
ASI	ARCHITECT'S SUPPLEMENTAL INSTRUCTION	COM	COMMON	ESCAL	ESCALATOR	GLU LAM	GLUED LAMINATED WOOD	LLV	LONG LEG VERTICAL	OD	OUTSIDE DIAMETER OUTSIDE DIMENSION	RECT	RECTANGLE	
ASKLR	AUTOMATIC SPRINKLER	COMB	COMBINATION, COMBINED	ESMT	EASEMENT	GR FL	GROUND FLOOR	LNDS	LANDSCAPE	OF/CI	OWNER FURNISHED/CONTRACTOR INSTALLED	REF	REFERENCE OR REFRIGERATOR	
ASPH	ASPHALT	COMM	COMMUNICATION	ESP	ESPECIALLY	GRAN	GRANITE	LR	LIVING ROOM			REFR	REFRACTORY REFRIGERATION	
ASSN	ASSOCIATION	COMP	COMPONENT	EST	ESTIMATE	GRTG	GRATING	LRG	LARGE					
ASTM	AMERICAN SOCIETY FOR TESTING AND MATERIALS	CONC	CONCRETE	ETC	AND SO FORTH OR ET CETERA	GSB	GYPSUM SHEATHING BOARD	LRV	LOUVERED ROOF VENT	OFD	OVERFLOW DRAIN	REFR	REFRIGERATION REFRACTORY	
ATCH	ATTACHMENT	CONC FLR	CONCRETE FLOOR	EW	EACH WAY	GSM	GALVANIZED SHEET METAL	LS	LUMP SUM	OFF	OFFICE	REG	REGISTER	
ATM	AUTOMATIC TELLER MACHINE	COND	CONDENSER OR CONDITION	EWG	ELECTRIC WATER COOLER	GSU	GLAZED STRUCTURAL UNIT	LT	LIGHT	OF/OI	OWNER FURNISHED/OWNER INSTALLED	REIN	REINFORCE	
ATS	AUTOMATIC TRANSFER SWITCH	CONF	CONFERENCE	EWS	EYE WASH STATION	GT	GROUT	LT GA	LIGHT GAGE			REPL	REPLACE	
AUTO	AUTOMATIC	CONN	CONNECT	EXH	EXHAUST	GUT	GUTTER	LT WT	LIGHT WEIGHT	OH	OVERHANG	REQ	REQUIRE	
AUX	AUXILIARY	CONSTR	CONSTRUCTION	EXIST	EXISTING	GYP	GYPSUM	LTNG	LIGHTNING	OH DR	OVERHEAD (COILING) DOOR	REQD	REQUIRED	
AV	AUDIO VISUAL	CONT	CONTINUE	EXP	EXPANSION OR EXPOSED	GYP BD	GYPSUM BOARD	LVD	LOUVERED	OPH	OPPOSITE HAND	RESIL	RESILIENT	
AVE	AVENUE	CONTR	CONTRACTOR	EXP BT	EXPANSION BOLT	GYP PLAS	GYPSUM PLASTER	LVR	LOUVER	OPNG	OPENING	RET	RETURN	
AVB	AIR VAPOR BARRIER	COORD	COORDINATE	EXST GR	EXISTING GRADE	H	HIGH	LWC	LIGHTWEIGHT CONCRETE	OPR	OPERABLE	REV	REVISION	
AW	ACID WASTE	CORR	CORRIDOR	EXT	EXTERIOR, EXTERNAL, OR EXTINGUISHER	H PLAM	HIGH PRESSURE PLASTIC LAMINATE	LWIC	LIGHTWEIGHT INSULATING CONCRETE LAYER	OPT	OPTIONAL	RF	RADIO FREQUENCY	
AWI	ARCHITECTURAL WOODWORKING INSTITUTE	CPM	CRITICAL PATH METHOD	EXT GR	EXTERIOR GRADE	HAZ MAT	HAZARDOUS MATERIALS	LYR	LAYER	OR	OPERATING ROOM OR OUTSIDE	RFG	ROOFING	
AWPA	AMERICAN WOOD PRESERVERS' ASSOCIATION	CPRS	COMPRESSIBLE	F	FAHRENHEIT OR FEMALE	HB	HOSE BIBB	MACH	MACHINE	ORD	ORDINANCE OR OVERFLOW ROOF DRAIN	RFI	REQUEST FOR INFORMATION	
AWS	AMERICAN WELDING SOCIETY	CPT	CARPET	FA	FIRE ALARM	HC	HOLLOW CORE	MACH RM	MACHINE ROOM			RFP	REQUEST FOR PROPOSAL	
AWT	ACOUSTICAL WALL TREATMENT	CRS	COLD ROLLED STEEL	FAB	FABRIC	HCD	HOLLOW CORE WOOD DOOR	MAINT	MAINTENANCE	ORG	ORGANIC	RH	RIGHT HAND	
B LABEL	CLASS B DOOR	CRSI	CONCRETE REINFORCING STEEL INSTITUTE	FAC	FACTOR	HDBD	HARDBOARD	MAN	MANUAL	ORIG	ORIGINAL	RHMS	ROUND HEAD MACHINE SCREW	
B PL	BASE PLATE	CSB	CONCRETE SPLASH BLOCK	FACIL	FACILITY	HDR	HIGH DENSITY OVERLAY	MATL	MATERIAL	ORN	ORNAMENTAL	RHR	RIGHT HAND REVERSE	
BALC	BALCONY	CSG	CASING	FAS	FASCIA	HDO	HEADER	MATV	MASTER ANTENNA TELEVISION SYSTEM	OSHA	OCCUPATIONAL SAFETY AND HEALTH ADMINISTRATION	RHWS	ROUND HEAD WOOD SCREW	
BALCONY	BALCONY	CSI	CONSTRUCTION SPECIFICATIONS INSTITUTE	FAS BD	FASCIA BOARD	HOR	HARDWARE			OUT	OUTLET	RL	RAILING	
BAT	BATTEN	CTY	COUNTER SUNK	FCO	FLOOR CLEANOUT	HOWD	HARDWOOD	MB	MACHINE BOLT	OZ	OUNCE	RM	ROOM	
BATTEN	BATTEN	CSK	CASEMENT	FCY	FACTORY	HEPA	HIGH EFFICIENCY PARTICULATE AIR (FILTER)	MCB	METAL CORNER BEAD			RND	ROUND	
BULLETIN BOARD	BULLETIN BOARD	CSMT	CASEMENT	FD	FLOOR DRAIN			MD	DECK	PAR	PARALLEL OR PARAPET	RO	ROUGH OPENING	
BOARD	BOARD	CSWK	CASEWORK	FDC	FIRE DEPARTMENT CONNECTION			ME	MECHANICAL ENGINEER	PART	PARTIAL	ROW	RIGHT OF WAY	
BOARD FEET (FOOT)	BOARD FEET (FOOT)	CT	CERAMIC TILE	FDTN	FOUNDATION	HEX	HEXAGON	MEAS	MEASURE			RPM	REVOLUTIONS PER MINUTE	
BEVEL	BEVEL	CTB	CERAMIC TILE BASE	FE	FIRE EXTINGUISHER	HF	HIGH FREQUENCY	MECH	MECHANICAL			RS	ROUGH SAWN	
BHMA	BUILDER'S HARDWARE	CTF	CERAMIC TILE FLOOR	HGR	HANGER	HM	HECTOMETER	MECH RM	MECHANICAL ROOM	PAT	PATTERN	RV	ROOF VENT	
BI FLD DR	BIFOLDING DOORS	CTG	COATING	HM	HOLLOW METAL	FF	FINISH FACE	MED	MEDICAL MEDIUM	PB	PUSHBUTTON	RVS	REVERSE	
BITUM	BITUMINOUS	CTR	CENTER CONTOUR	FF EL	FINISH FLOOR ELEVATION	HMD	HOLLOW METAL DOOR	MED	MEDIUM MEDICAL	PBD	PARTICLEBOARD	RWD	REDWOOD	
BKG	BACKING	CU	CABLE TELEVISION	FF&E	FURNITURE, FIXTURE, AND EQUIPMENT	HMD	HOLLOW METAL DOOR AND FRAME	MEK	METHYL ETHYL KETONE	PC	PIECE, POLYCARBONATE OR PORTLAND CEMENT	RWL	RAIN WATER LEADER	
BLD	BUILD	CU FT	CUBIC FEET	FH	FLAT HEAD OR FLAT HEAD SCREWS	HMF	HOLLOW METAL FRAME	MEL	MELAMINE	PCA	PORTLAND CEMENT ASSOCIATION	SA	SUPPLY AIR	
BLDG	BUILDING	CU IN	CUBIC INCH	FHC	FIRE HOSE CABINET	HNDRL	HANDRAIL	MEMB	MEMBRANE	PCC	PRECAST CONCRETE	SA	SALVAGE	
BLKT	BLANKET	CU YD	CUBIC YARD	FHM	FLAT HEAD MACHINE SCREW	HO	HOLD OPEN	MEMO	MEMORANDUM	PCCP	CONCRETE PAVEMENT	SAMP	SAMPLE	
BLVD	BOULEVARD	CURT	CURTAIN	FHP	FULL HEIGHT PARTITION	HORIZ	HORIZONTAL	MEZZ	MEZZANINE	PCD				

<b>CONSULTANTS:</b>		<b>ARCHITECT/ENGINEERS:</b>		<b>Drawing Title</b>		<b>Project Title</b>		<b>Project Number</b>		<b>Office of Construction and Facilities Management</b> Department of Veterans Affairs	
				<b>ABBREVIATIONS</b>		<b>DEPARTMENT OF VETERANS AFFAIRS</b>		<b>688-334 OIF/OEF</b>			
						<b>VAMC</b>		<b>Building Number</b>			
								<b>Drawing Number</b>			
<b>ISSUE 1 - ISSUE FOR CONSTRUCTION</b>		<b>04/30/2013</b>		<b>Approved Project Director</b>		<b>Location Veterans Affairs Medical Center</b>		<b>4-30-2013</b>		<b>G1003</b>	
<b>65 % SUBMISSION</b>		<b>02/17/2012</b>				<b>30 Irving Street NW Washington DC</b>		<b>CH</b>		<b>AN</b>	
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<b>Revisions</b>		<b>Date</b>									



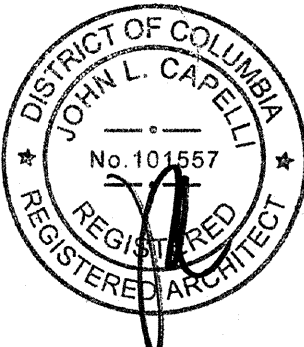


ARCHITECTURAL ABBREVIATIONS

SCT	STRUCTURAL CLAY TILE	U	HEAT TRANSFER COEFFICIENT
SCWD	SOLID CORE WOOD DOOR	UC	UNDERCUT
SD	SHOP DRAWINGS, SMOKE DETECTOR, OR SOAP DISPENSER; STORM DRAIN	UCD	UNDERCUT DOOR
SDG	SIDING	UGND	UNDERGROUND
SECT	SECTION	UL	UNDERWRITERS LABORATORIES
SEG	SEGMENT	ULT	ULTIMATE
SEL	SELECT	UNFIN	UNFINISH
SEP	SEPARATE	UON	UNLESS OTHERWISE NOTED
SF	SQUARE FOOT (FEET)	UPS	UNINTERRUPTIBLE POWER SUPPLY
SFTWD	SOFTWOOD	UR	URINAL
SGD	SLIDING GLASS DOOR	UTIL	UTILITY
SGL	SINGLE	UV	ULTRAVIOLET
SHR	SHOWER	V	VOLT
SHR HD	SHOWER HEAD	VAC	VACUUM
SHRD	SHOWER DRAIN	VAR	VARIABLE
SHT	SHEET	VCT	VINYL COMPOSITION TILE
SHT MTL FLASH	SHEET METAL (FLASHING)	VEH	VITRIFIED CLAY TILE
SHTHG	SHEATHING	VENT	VENTILATION
SHV	SHELVING	VERT	VERTICAL
SIM	SIMILAR	VEST	VESTIBULE
SJ	SCORED JOINT	VFAT	VINYL FACED ACOUSTICAL TILE
SJI	STEEL JOIST INSTITUTE	VIC	VICINITY
SK	SKETCH	VID	VIDEO
SKLT	SKYLIGHT	VIF	VERIFY IN FIELD
SLD WDW	HORIZONTAL SLIDING WINDOW	VNR	VENEER
SLDG	SLIDING	VOC	VOLATILE ORGANIC COMPOUND
SLNT	SEALANT	VOL	VOLUME
SM	SHEET METAL	VOLT	VOLTAGE
SMK	SMOKE	VP	VENEER PLASTER
SND	SANITARY NAPKIN DISPENSER	VR	VAPOR RETARDER
SND INS	SOUND INSULATION	VTR	VENT THROUGH ROOF
SNDU	SANITARY NAPKIN DISPOSAL	VWC	VINYL WALL COVERING
SPEC	SPECIFICATION	VWF	VINYL WALL FABRIC
SPKLR	SPRINKLER	W	WIDE OR WEST
SPKR	SPEAKER	W/	WITH
SPLY	SUPPLY	W/O	WITHOUT
SQ	SQUARE	WARR	WARRANTY
SQ IN	SQUARE INCH	WBL	WOOD BLOCKING
SQ YD	SQUARE YARD	WC	WALL COVERING OR WATER CLOSET
SS	SANITARY SEWER OR SERVICE SINK	WC WL HNG	WATER CLOSET, WALL HUNG
SST	STAINLESS STEEL	WCHR	WATER CHILLER
ST	STAIRS OR STREET	WCL WL MTD	WATER COOLER, WALL HUNG
STC	SOUND TRANSMISSION CLASS	WD	WOOD
STD	STANDARD	WDW	WINDOW
STIF	STIFFENER	WF	WIDE FLANGE
STL JST	STEEL JOIST	WFAB	WALL FABRIC
STL LNTL	STEEL UNTEL	WFR	WOOD FRAME
STL PL	STEEL PLATE	WFS	WOOD FURRING STRIPS
STL RF DK	STEEL ROOF DECK	WH	WATER HEATER
STL TB	STEEL TUBE	WHSE	WAREHOUSE
STL TR	STEEL TRUSS	WLD	WELDED
STNLS	STAINLESS	WM	WIRE MESH
STOR	STORAGE	WP	WATERPROOFING
STR	STRINGERS	WPD	WATER PRESSURE DROP
STRUCT	STRUCTURAL	WPM	WATERPROOF MEMBRANE
STRUCT STL	STRUCTURAL STEEL	WR	WEATHER RESISTANT
SUB	SUBSTITUTE	WS	WEATHERSTRIP
SURF	SURFACE	WSCT	WAINSCOT
SUSP	SUSPEND	WT	WEIGHT
SUSP CLG	SUSPENDED CEILING	WWF	WELDED WIRE FABRIC
SV	SHEET VINYL	X BRACE	CROSS BRACE
SW	SWITCH	XPS	EXTRUDED POLYSTYRENE BOARD (INSULATION)
SWDR	SWING DOOR	YD	YARD
SYM	SYMBOL	YR	YEAR
SYNTH	SYNTHETIC		
SYS	SYSTEM		
T	TREAD		
T&G	TONGUE AND GROOVE		
T&M	TIME AND MATERIALS		
TB	THROUGH BOLT OR TOWEL BAR		
TCA	TILE COUNCIL OF AMERICA		
TCP	TELEPHONE CONTROL PANEL		
TD	TECHNICAL		
TECH	TECHNICAL		
TEL	TELEPHONE		
TEMP	TEMPERATURE OR TEMPORARY		
TER	TERRAZZO		
THD	THREAD		
THERM	THERMAL		
THK	THICKNESS		
THRES	THRESHOLD		
THRU	THROUGH		
THRUOUT	THROUGHOUT		
TK BD	TACKBOARD		
TMPD	TEMPERED		
TMPD GL	TEMPERED GLASS		
TN	TRUE NORTH		
TO	TOP OF		
TO FDN	TOP OF FOUNDATION		
TOB	TOP OF BEAM		
TOM	TOP OF MASONRY		
TOP	TOP OF PARAPET		
TOS	TOP OF STEEL		
TOW	TOP OF WALL		
TPD	TOILET PAPER DISPENSER		
TPH	TOILET PAPER HOLDER		
TR	TOWEL RACK		
TRANS	TRANSOM		
TRANS WD FIN	TRANSPARENT WOOD FINISH		
TRTD	TREATED		
TS	TENSILE STRENGTH OR TUBE		
TSTAT	STEEL		
TV	THERMOSTAT		
TYP	TELEVISION		
	TYPICAL		

CONSULTANTS:

ARCHITECT/ENGINEERS:



EWING  
COLE

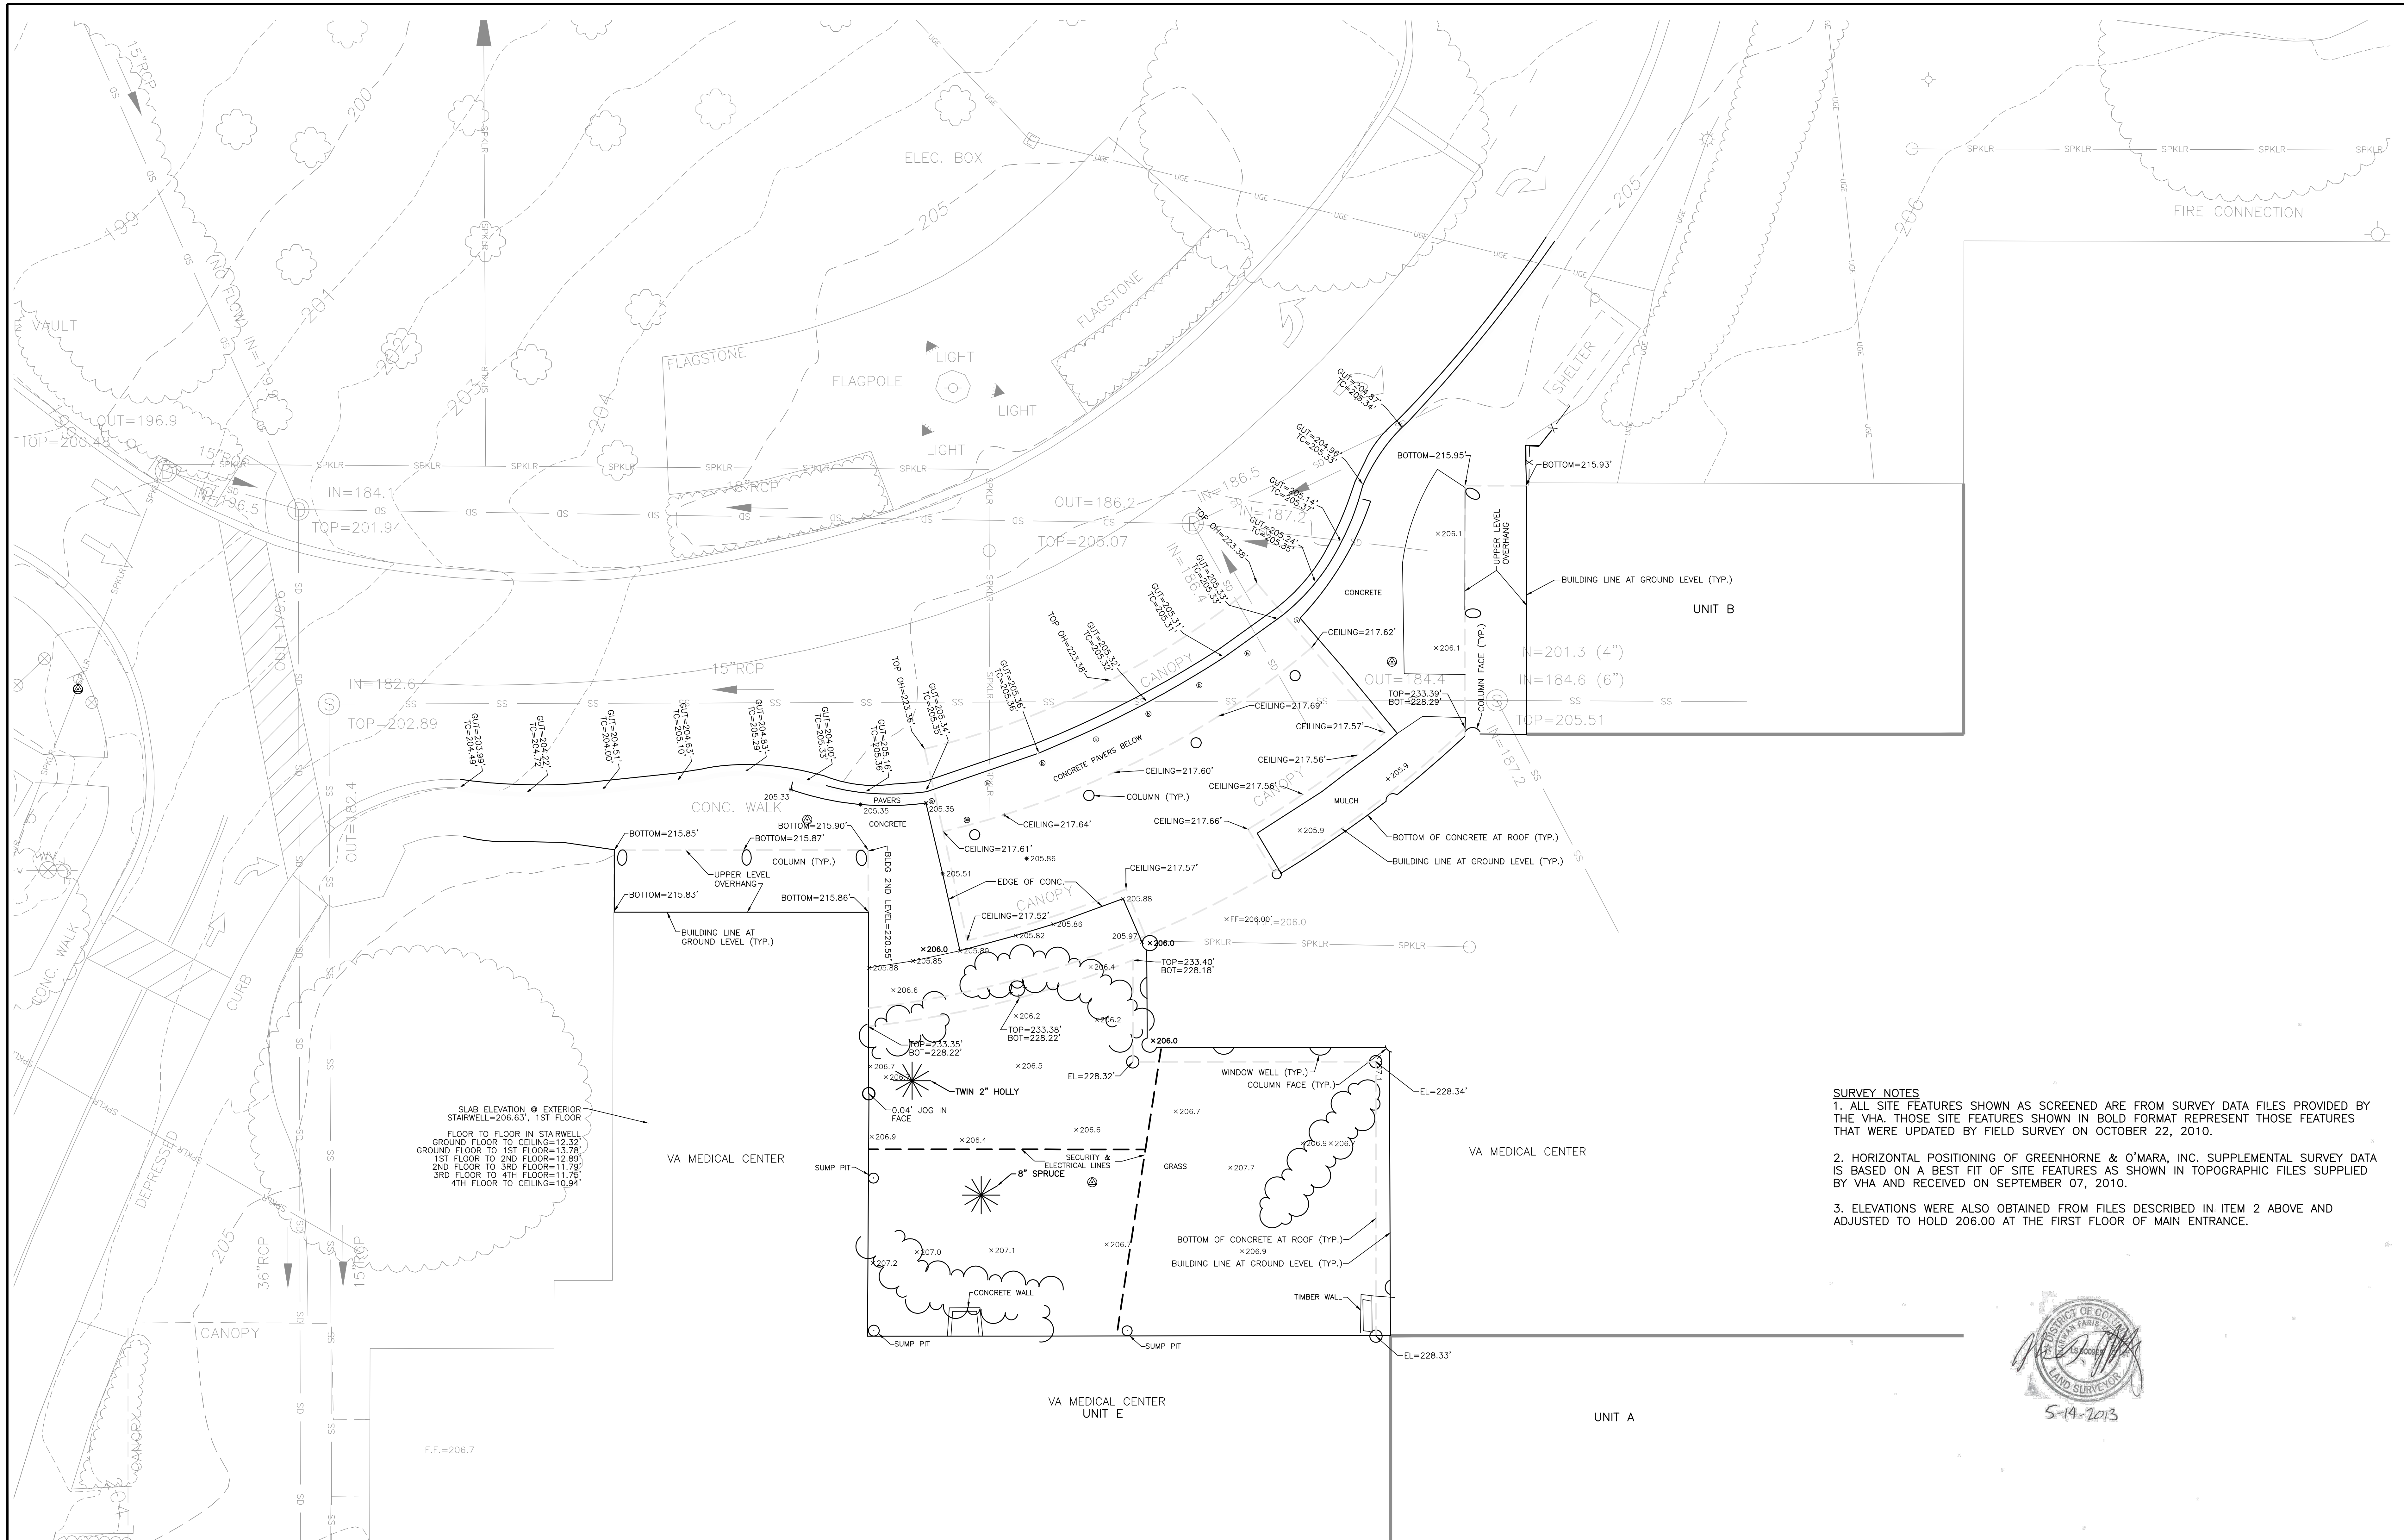
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Suite 900  
Washington, DC 20036-5405  
Tel: 202-467-1500 Fax: 202-296-8950




Drawing Title	Project Title	Project Number	Office of Construction and Facilities Management  Department of Veterans Affairs
ABBREVIATIONS	OIF / OEF WELCOME CENTER DEPARTMENT OF VETERANS AFFAIRS VAMC	688-334 OIF/OEF	
Approved Project Director	Location Veterans Affairs Medical Center 50 Irving Street NW Washington DC	Building Number	
	Date	Checked	Drawing Number
	4-30-2013	CH	GI004





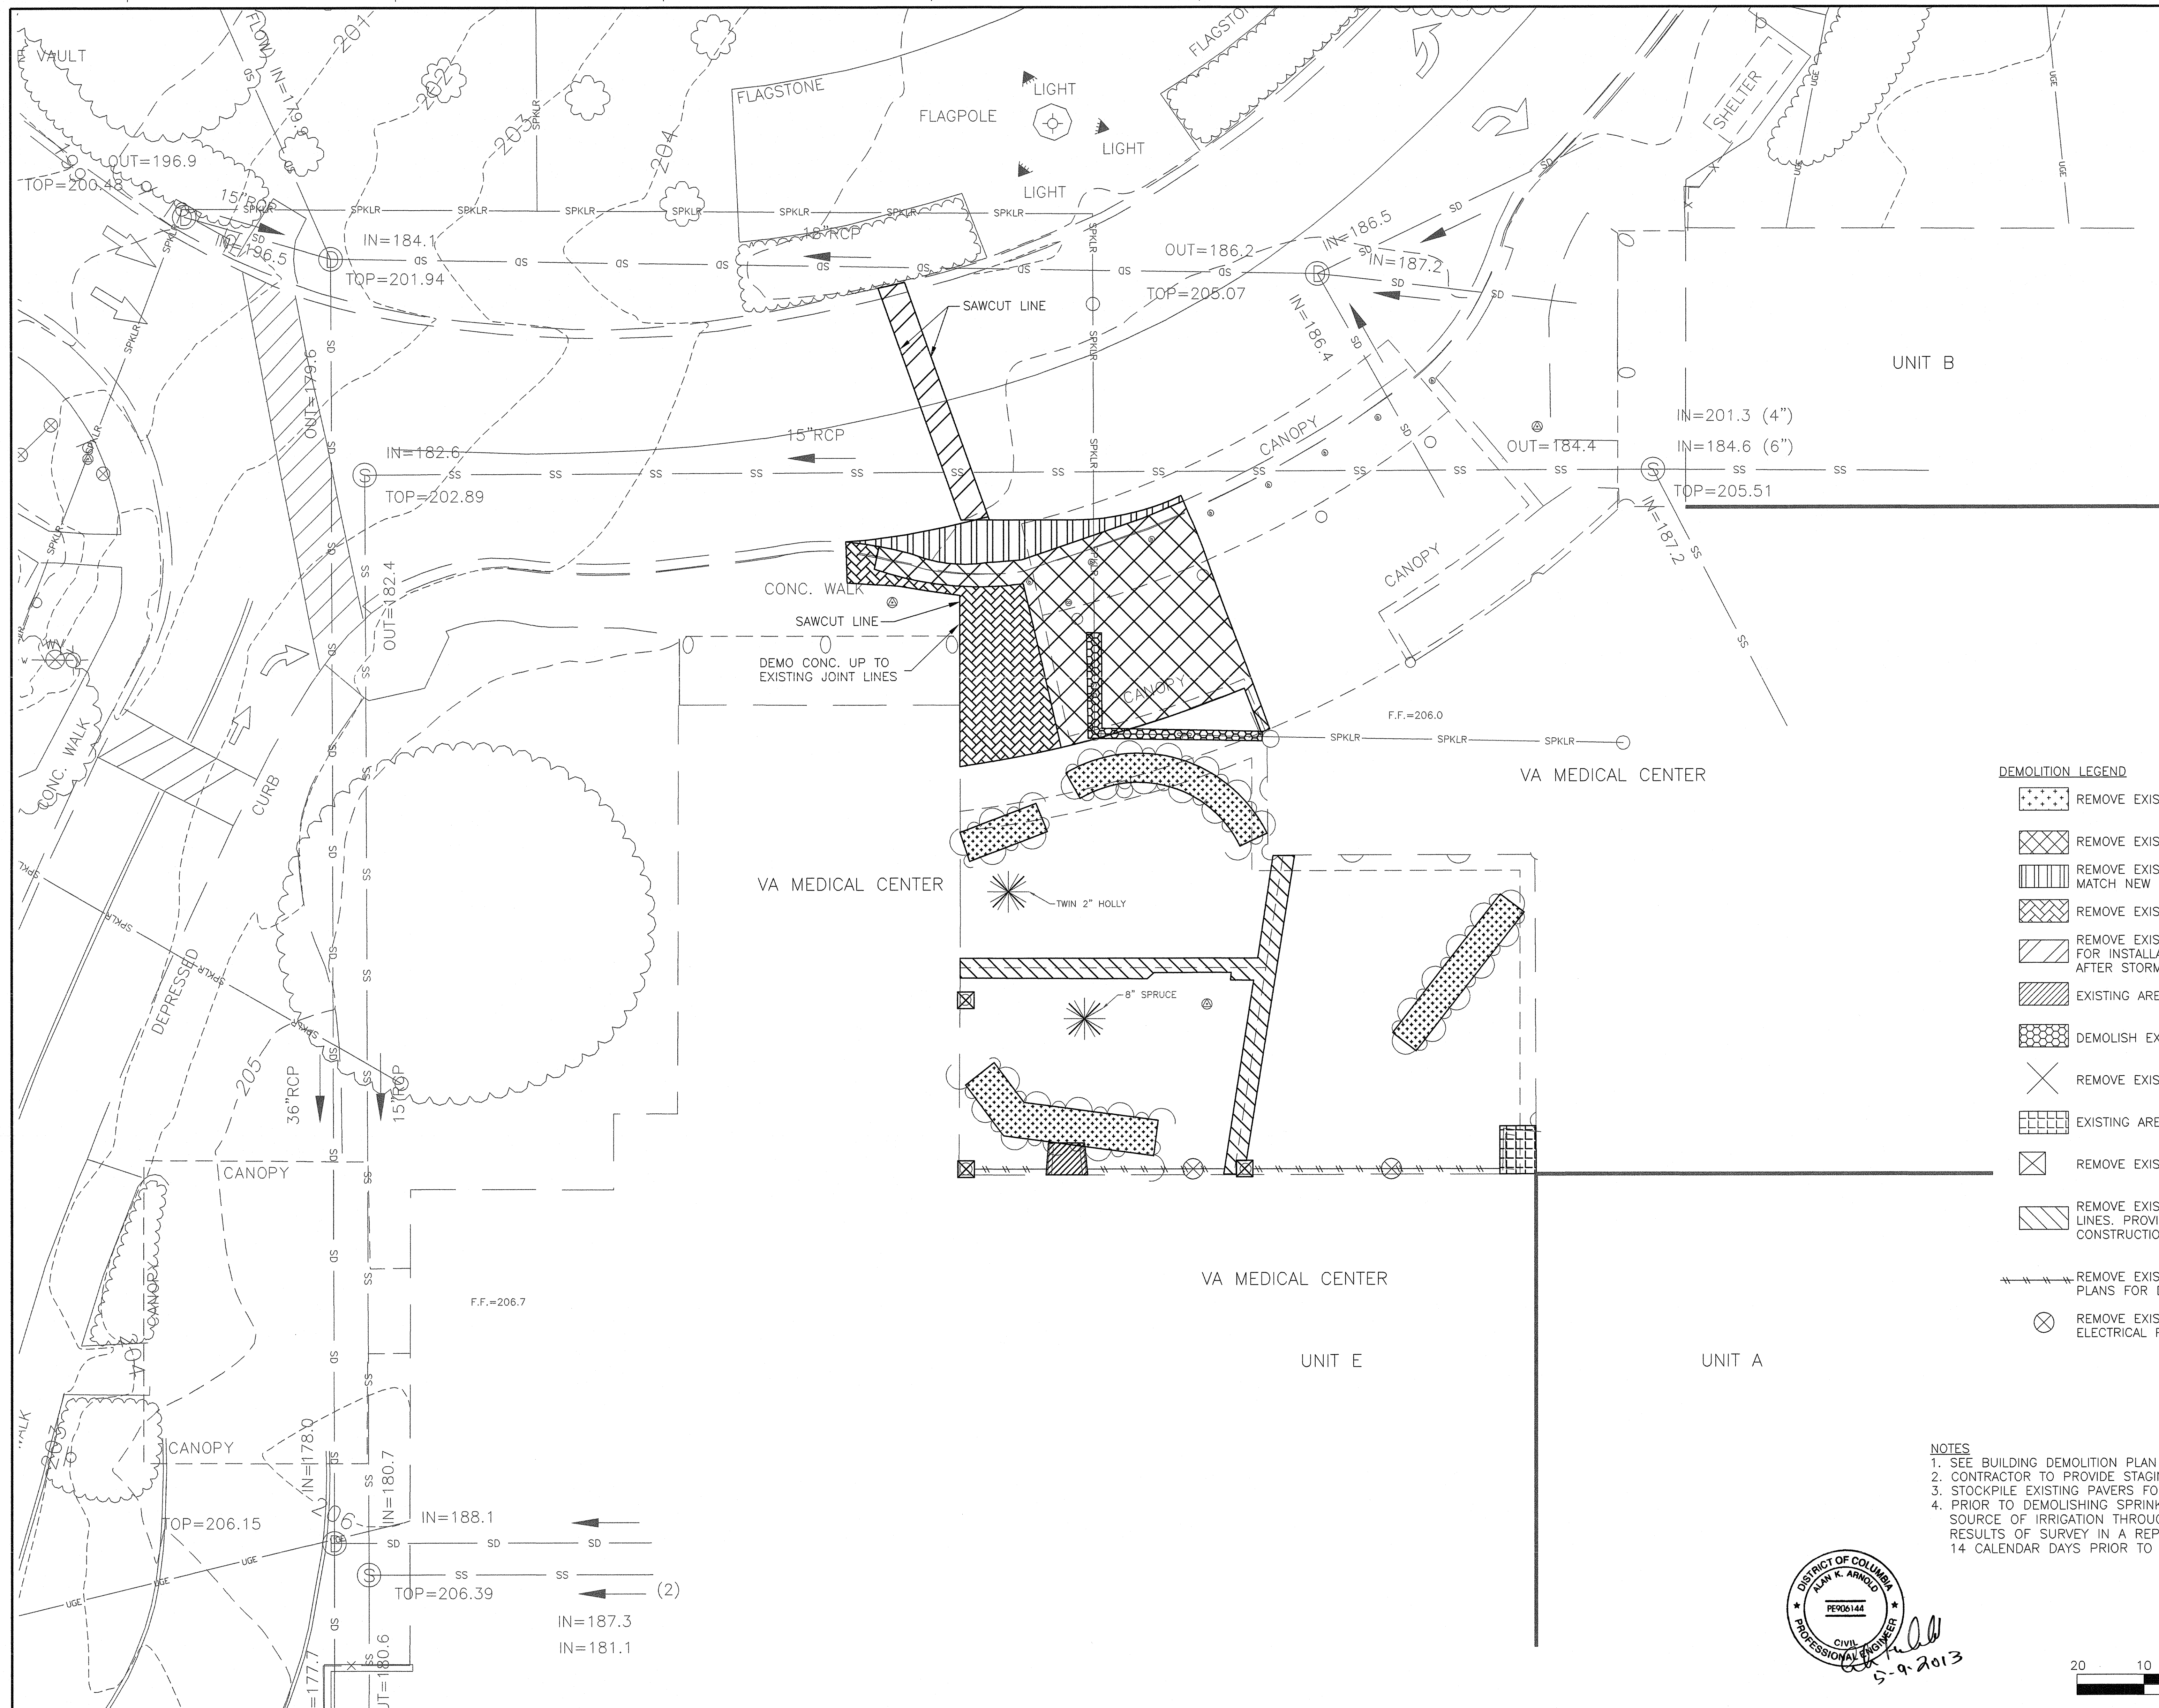




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		 GREENHORNE & O'MARA, INC. 6110 FROST PLACE LAUREL, MD 20707 PHONE: 301-982-2800 FAX: 301-220-2619				 EWING COLE 1025 Connecticut Avenue, NW Suite 900 Washington, DC 20036-5405 Tel: 202-467-1500 Fax: 202-296-8950		Approved Project Director		Location Veterans Affairs Medical Center 50 Irving Street NW Washington DC		Drawing Number V101					
ISSUE 1 - READY TO ADVERTISE 04.30.2013 95 % SUBMISSION 02.17.2012 75 % SUBMISSION 03.16.2011 25 % SUBMISSION 10.29.2010 Revisions: Date										Date 4-30-2013		Checked E		Drawn JMS		 Department of Veterans Affairs	

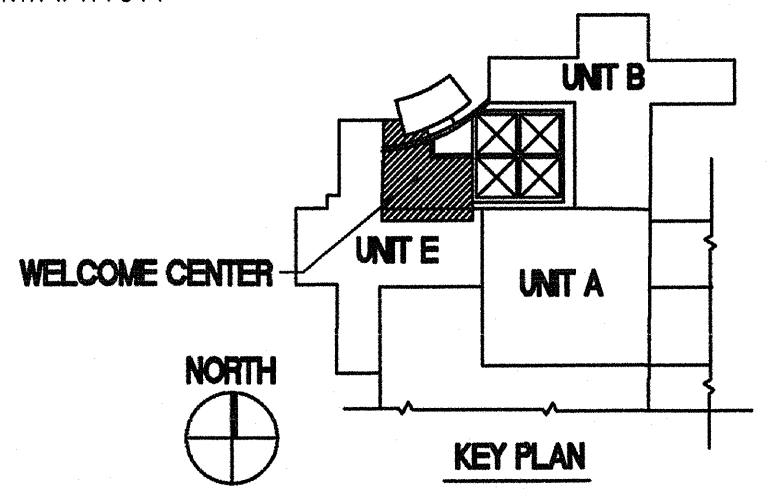
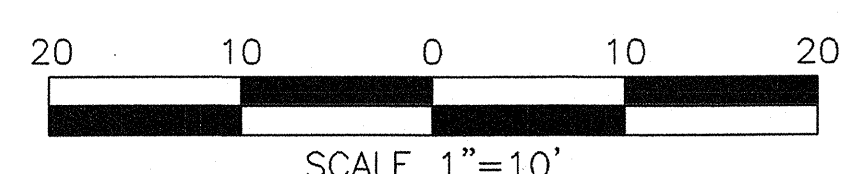
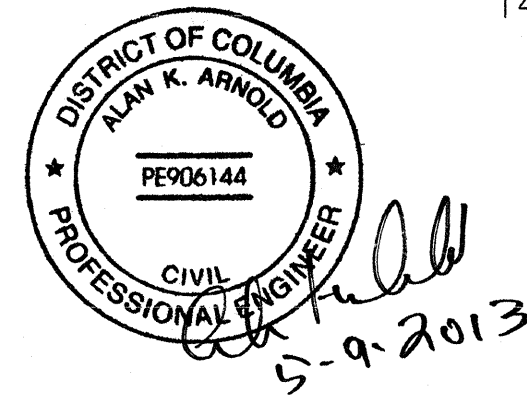





three inches = one foot  
one and one half inches = one foot  
one inch = one foot  
three quarters inch = one foot  
one half inch = one foot  
one quarter inch = one foot  
one eighth inch = one foot  
one sixteenth inch = one foot



- DEMOLITION LEGEND**
- REMOVE EXISTING SHRUBBERY
  - REMOVE EXISTING PAVERS
  - REMOVE EXISTING PAVERS AND GRANITE STRIP CUT GRANITE STRIP TO MATCH NEW CURB LINE
  - REMOVE EXISTING CONCRETE
  - REMOVE EXISTING CURB, PAVING AND ASSOCIATED SUB BASE MATERIALS FOR INSTALLATION OF STORM DRAIN. REPLACE IN KIND AFTER STORM LINE IS PLACED.
  - EXISTING AREAWAY TO REMAIN, REMOVE EXISTING CAP
  - DEMOLISH EXISTING SPRINKLER LINE SEE NOTE 4.
  - REMOVE EXISTING TREE
  - EXISTING AREAWAY TO REMAIN, REMOVE EXISTING CAP
  - REMOVE EXISTING SUMP PIT
  - REMOVE EXISTING SECURITY AND ELECTRICAL LINES. PROVIDE TEMPORARY SERVICES DURING CONSTRUCTION
  - REMOVE EXISTING PIPING, SEE ELECTRICAL PLANS FOR DETAILS
  - REMOVE EXISTING ELECTRICAL OUTLETS, SEE ELECTRICAL PLANS FOR DETAILS

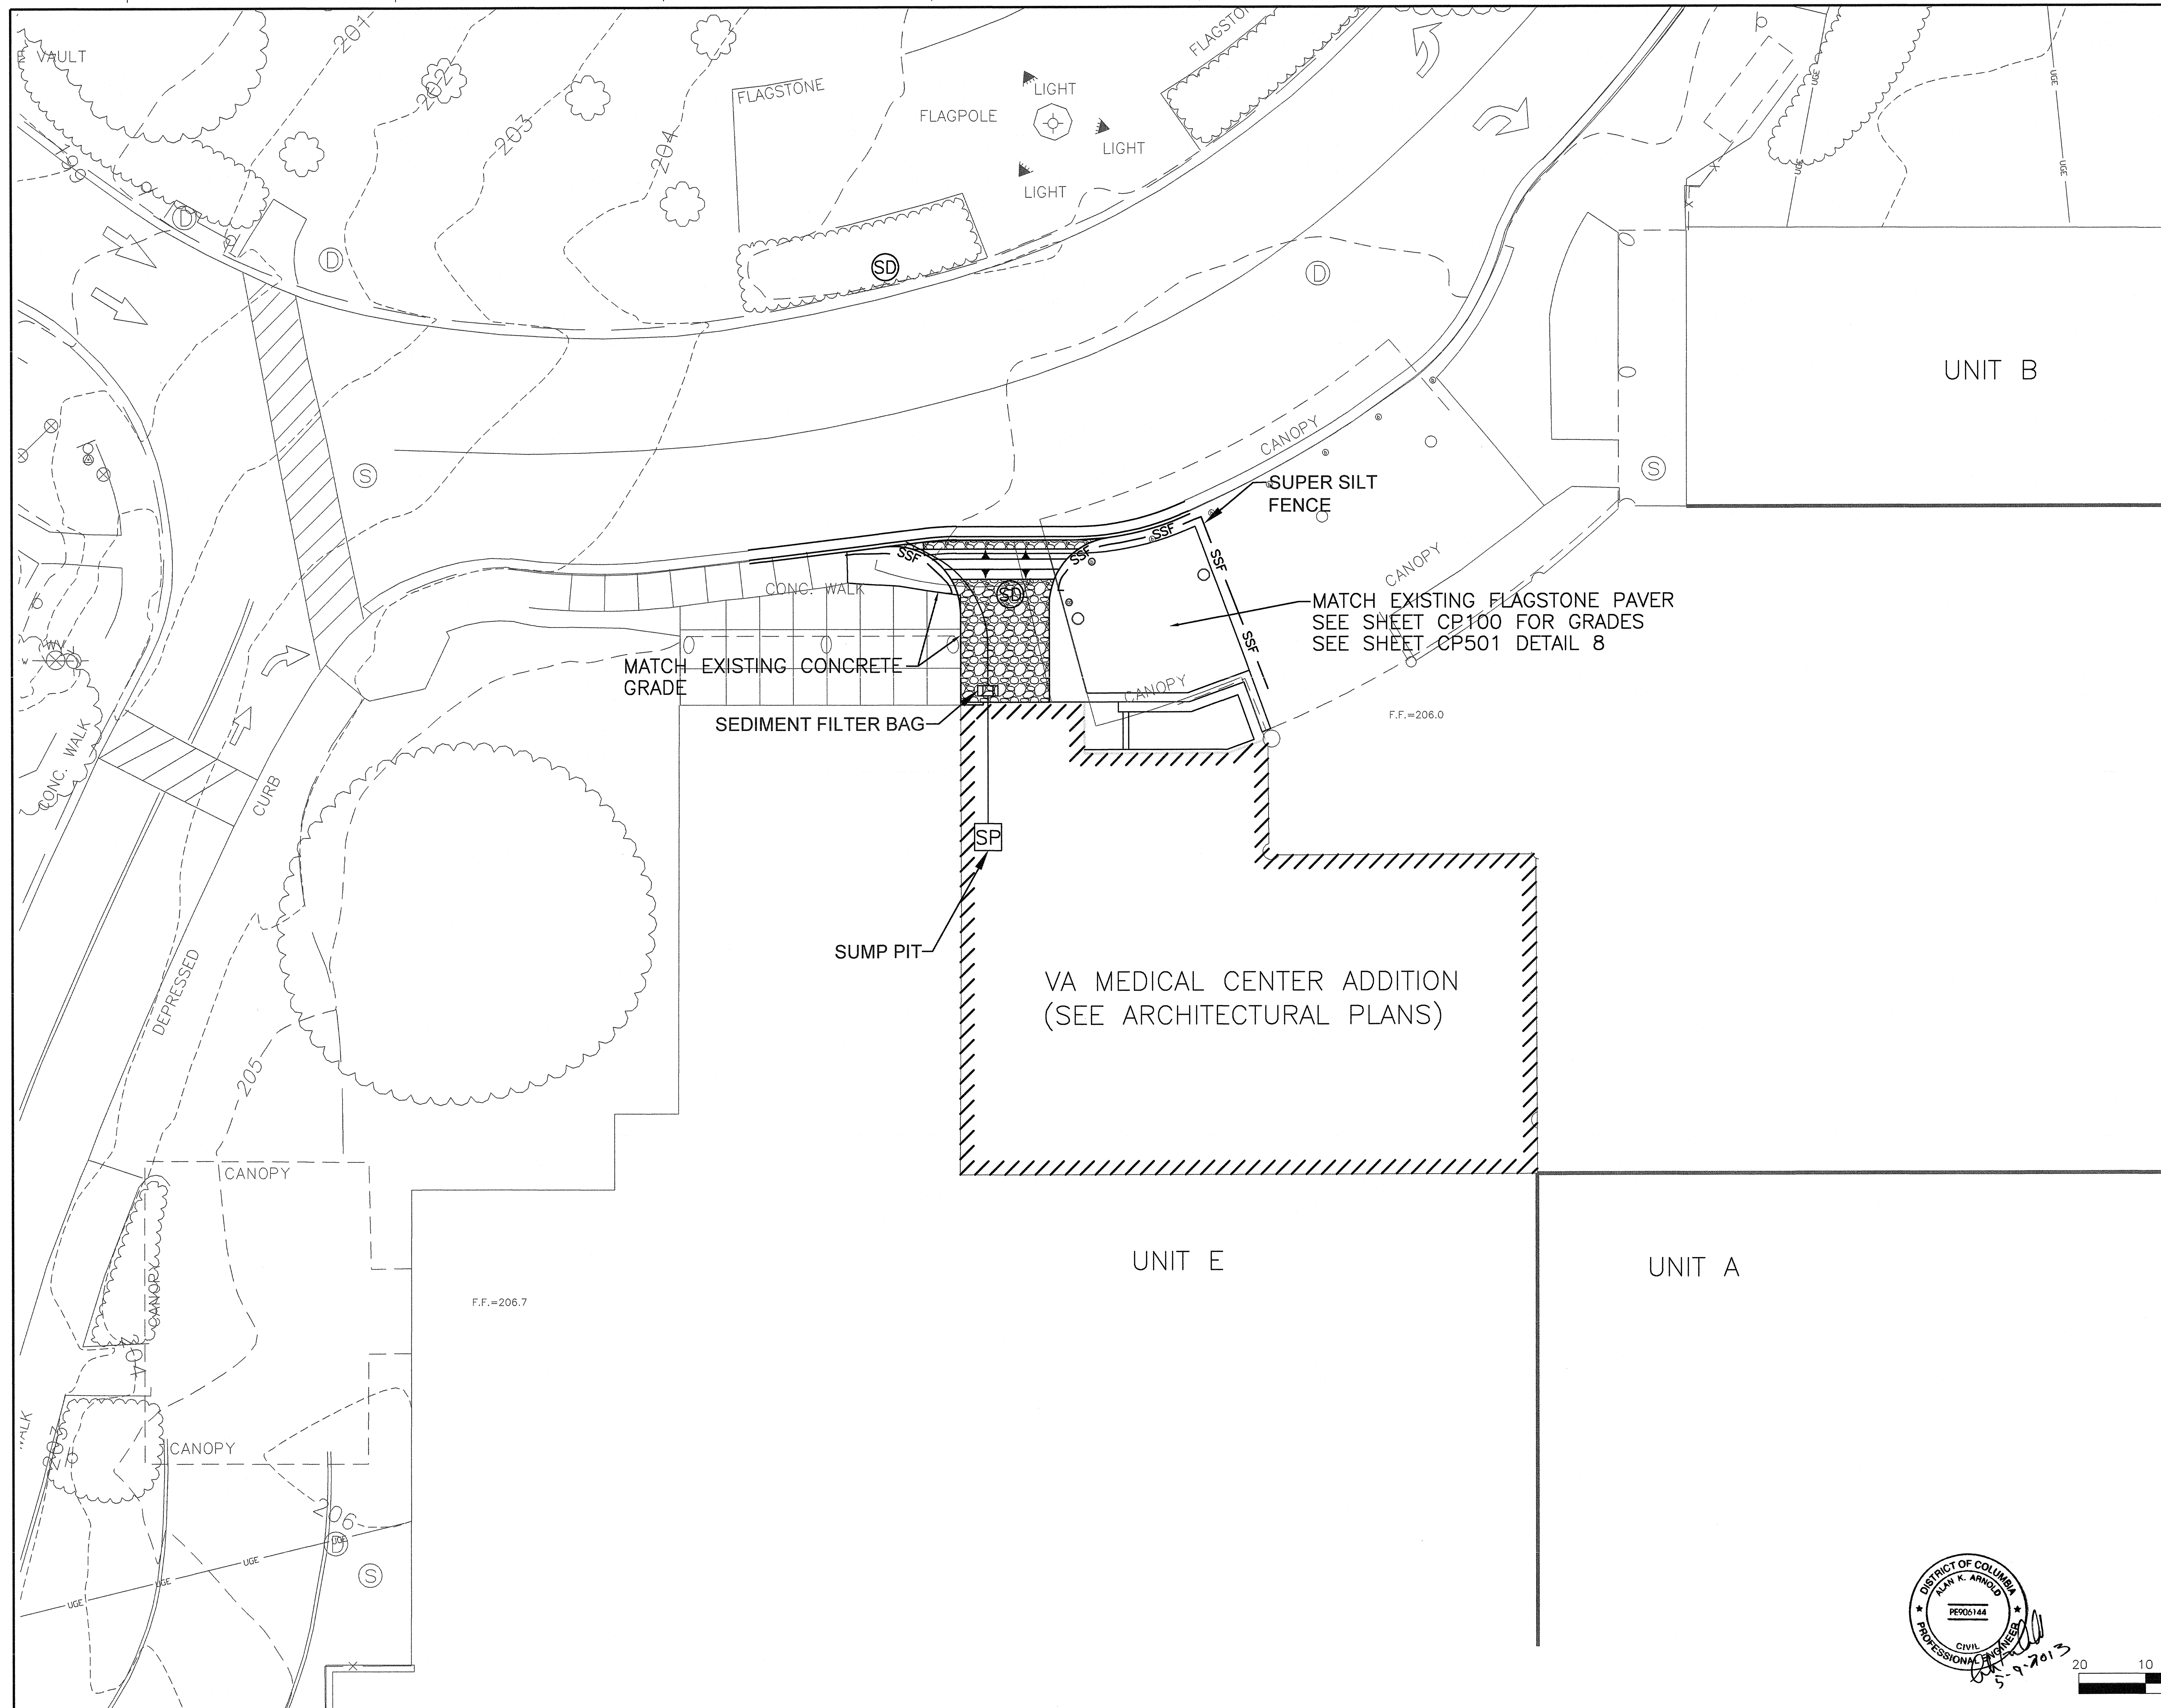
- NOTES**
- SEE BUILDING DEMOLITION PLAN FOR BUILDING ELEMENTS DEMOLITION
  - CONTRACTOR TO PROVIDE STAGING AND LAYDOWN AREA OFFSITE.
  - STOCKPILE EXISTING PAVERS FOR REUSE.
  - PRIOR TO DEMOLISHING SPRINKLER LINE VERIFY ROUTING, PIPE SIZES, AND SOURCE OF IRRIGATION THROUGH SURVEY. PROVIDE TO CONTRACTING OFFICER RESULTS OF SURVEY IN A REPORT FOR HIS REVIEW & DETERMINATION 14 CALENDAR DAYS PRIOR TO SCHEDULE START OF WORK.



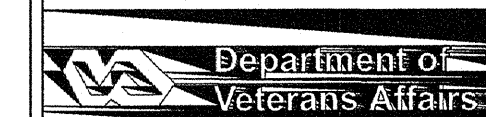


		<b>CONSULTANTS:</b>				<b>ARCHITECT/ENGINEERS:</b>		<b>Drawing Title</b> <b>Civil Demolition Plan</b>		<b>Project Title</b> <b>OIF / OEF WELCOME CENTER</b> <b>DEPARTMENT OF VETERANS AFFAIRS</b> <b>VAMC</b>		<b>Project Number</b> <b>688-334 OIF/OEF</b>		<b>Office of Construction and Facilities Management</b>												
		 <b>GREENHORNE &amp; O'MARA, INC.</b> 6110 FROST PLACE LAUREL, MD 20707 PHONE: 301-982-2800 FAX: 301-220-2619				 <b>EWING COLE</b>  1025 Connecticut Avenue, NW Suite 900 Washington, DC 20036-5405 Tel: 202-467-1500 Fax: 202-296-8950		<b>Approved Project Director</b>		<b>Location</b> <b>Veterans Affairs Medical Center</b> 50 Irving Street NW Washington DC		<b>Building Number</b> -														
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two inches = one foot  
three inches = one foot



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<b>ISSUE 1 - ISSUE FOR CONSTRUCTION</b> 95 % SUBMISSION 75 % SUBMISSION 25 % SUBMISSION Revisions:				<b>Approved Project Director</b>		<b>Location</b> Veterans Affairs Medical Center 50 Irving Street NW Washington DC		<b>Building Number</b> -		<b>Drawing Number</b> <b>CG101</b>	
04.30.2013 02.17.2012 03.16.2011 10.29.2010 Date						<b>Date</b> 4-30-2013		<b>Checked</b> JMS		<b>Drawn</b> EI	

